


CONNECTION SCHEDULE	
CONNECTION	SIZE & DESCRIPTION
MAIN STEAM OUTLET	
MAIN STEAM SPOOL DRAIN	
SAFETY VALVE(S)	
STEAM DRUM VENT	
FEEDWATER INLET	
FEEDWATER STATION DRAIN	
CHEMICAL FEED	
INTERMITTENT BLOWDOWN	
CONTINUOUS BLOWDOWN	
HEATING COIL(S)	
OBSERVATION PORT	
FRONT TRIM DRAIN	
ECONOMIZER VENT	
ECONOMIZER SRV	
ECONOMIZER DRAIN	

PRELIMINARY


BOILER DATA	
MODEL NUMBER	60-D-xxx
GROSS CAPACITY	60,000 LB/HR
DESIGN PRESSURE	
OPERATING PRESSURE	
SATURATED STEAM TEMP.	
FEEDWATER TEMP.	
ELEVATION	<1,000 FT
FUEL	NAT. GAS

NOTES:


1. DESIGNED & FABRICATED ACCORDING TO ASME SECTION 1, FOR POWER BOILERS AND PRESSURE VESSELS 2021 EDITION.

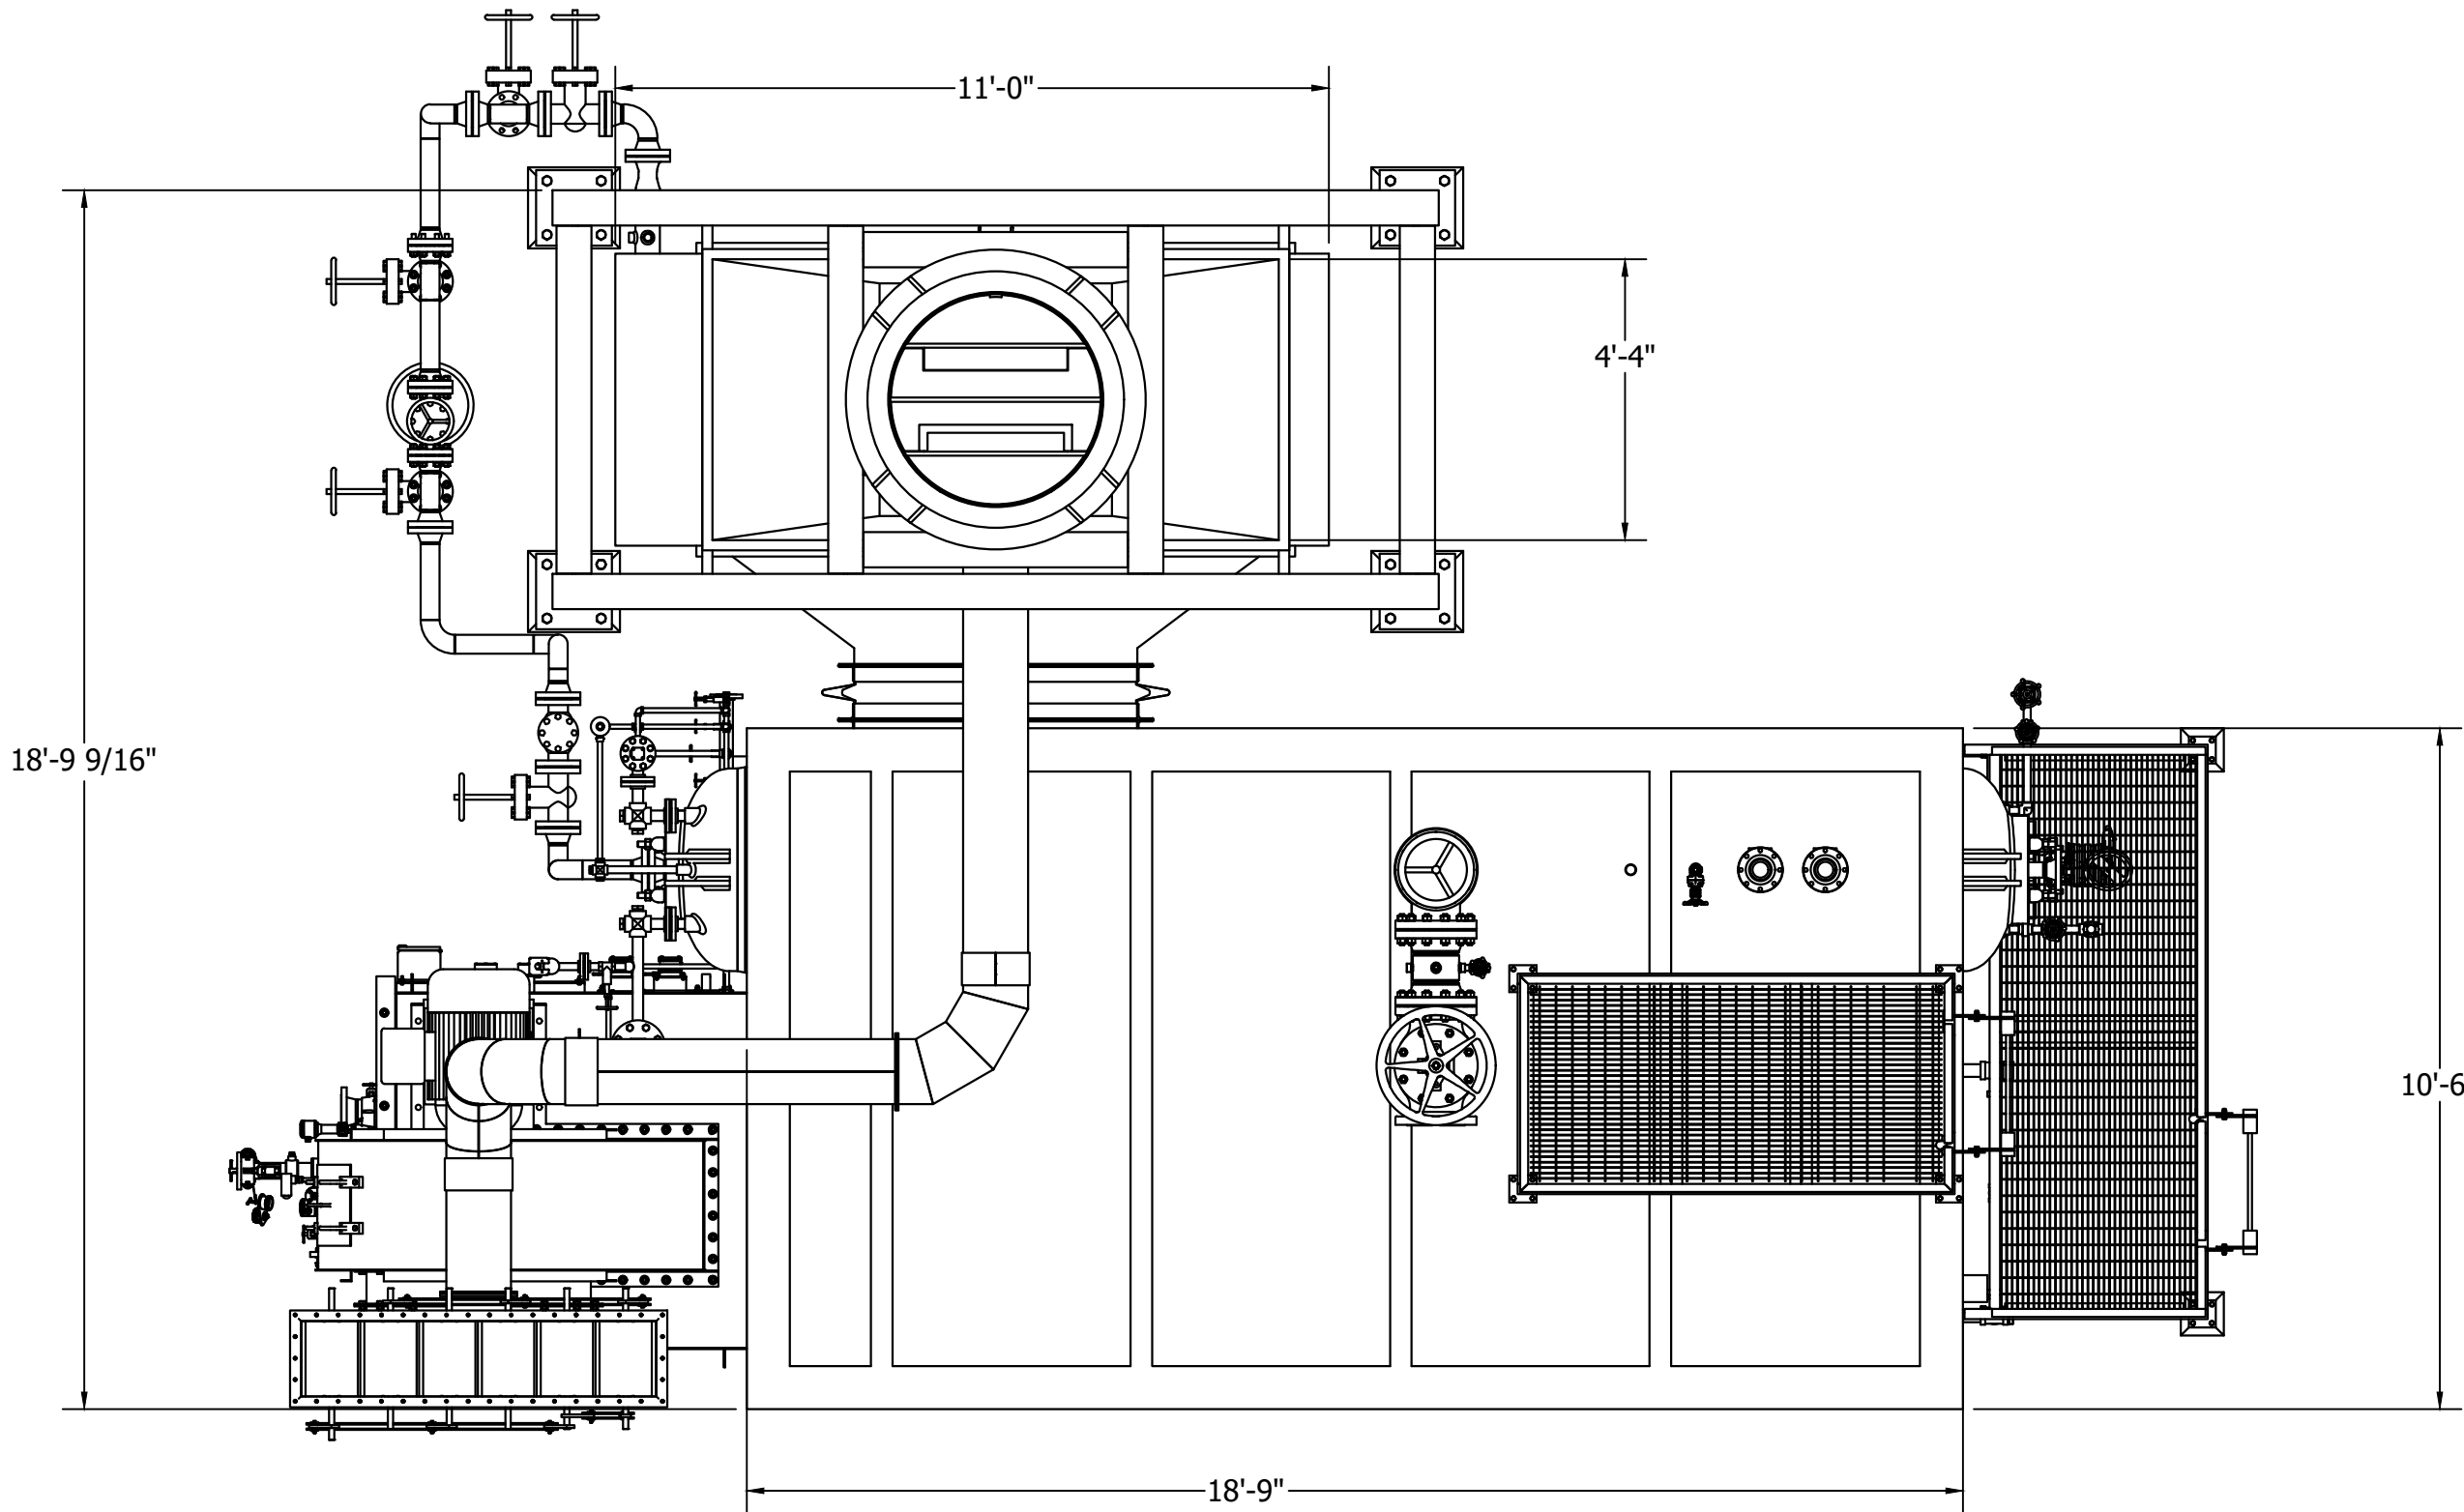


PLAN VIEW

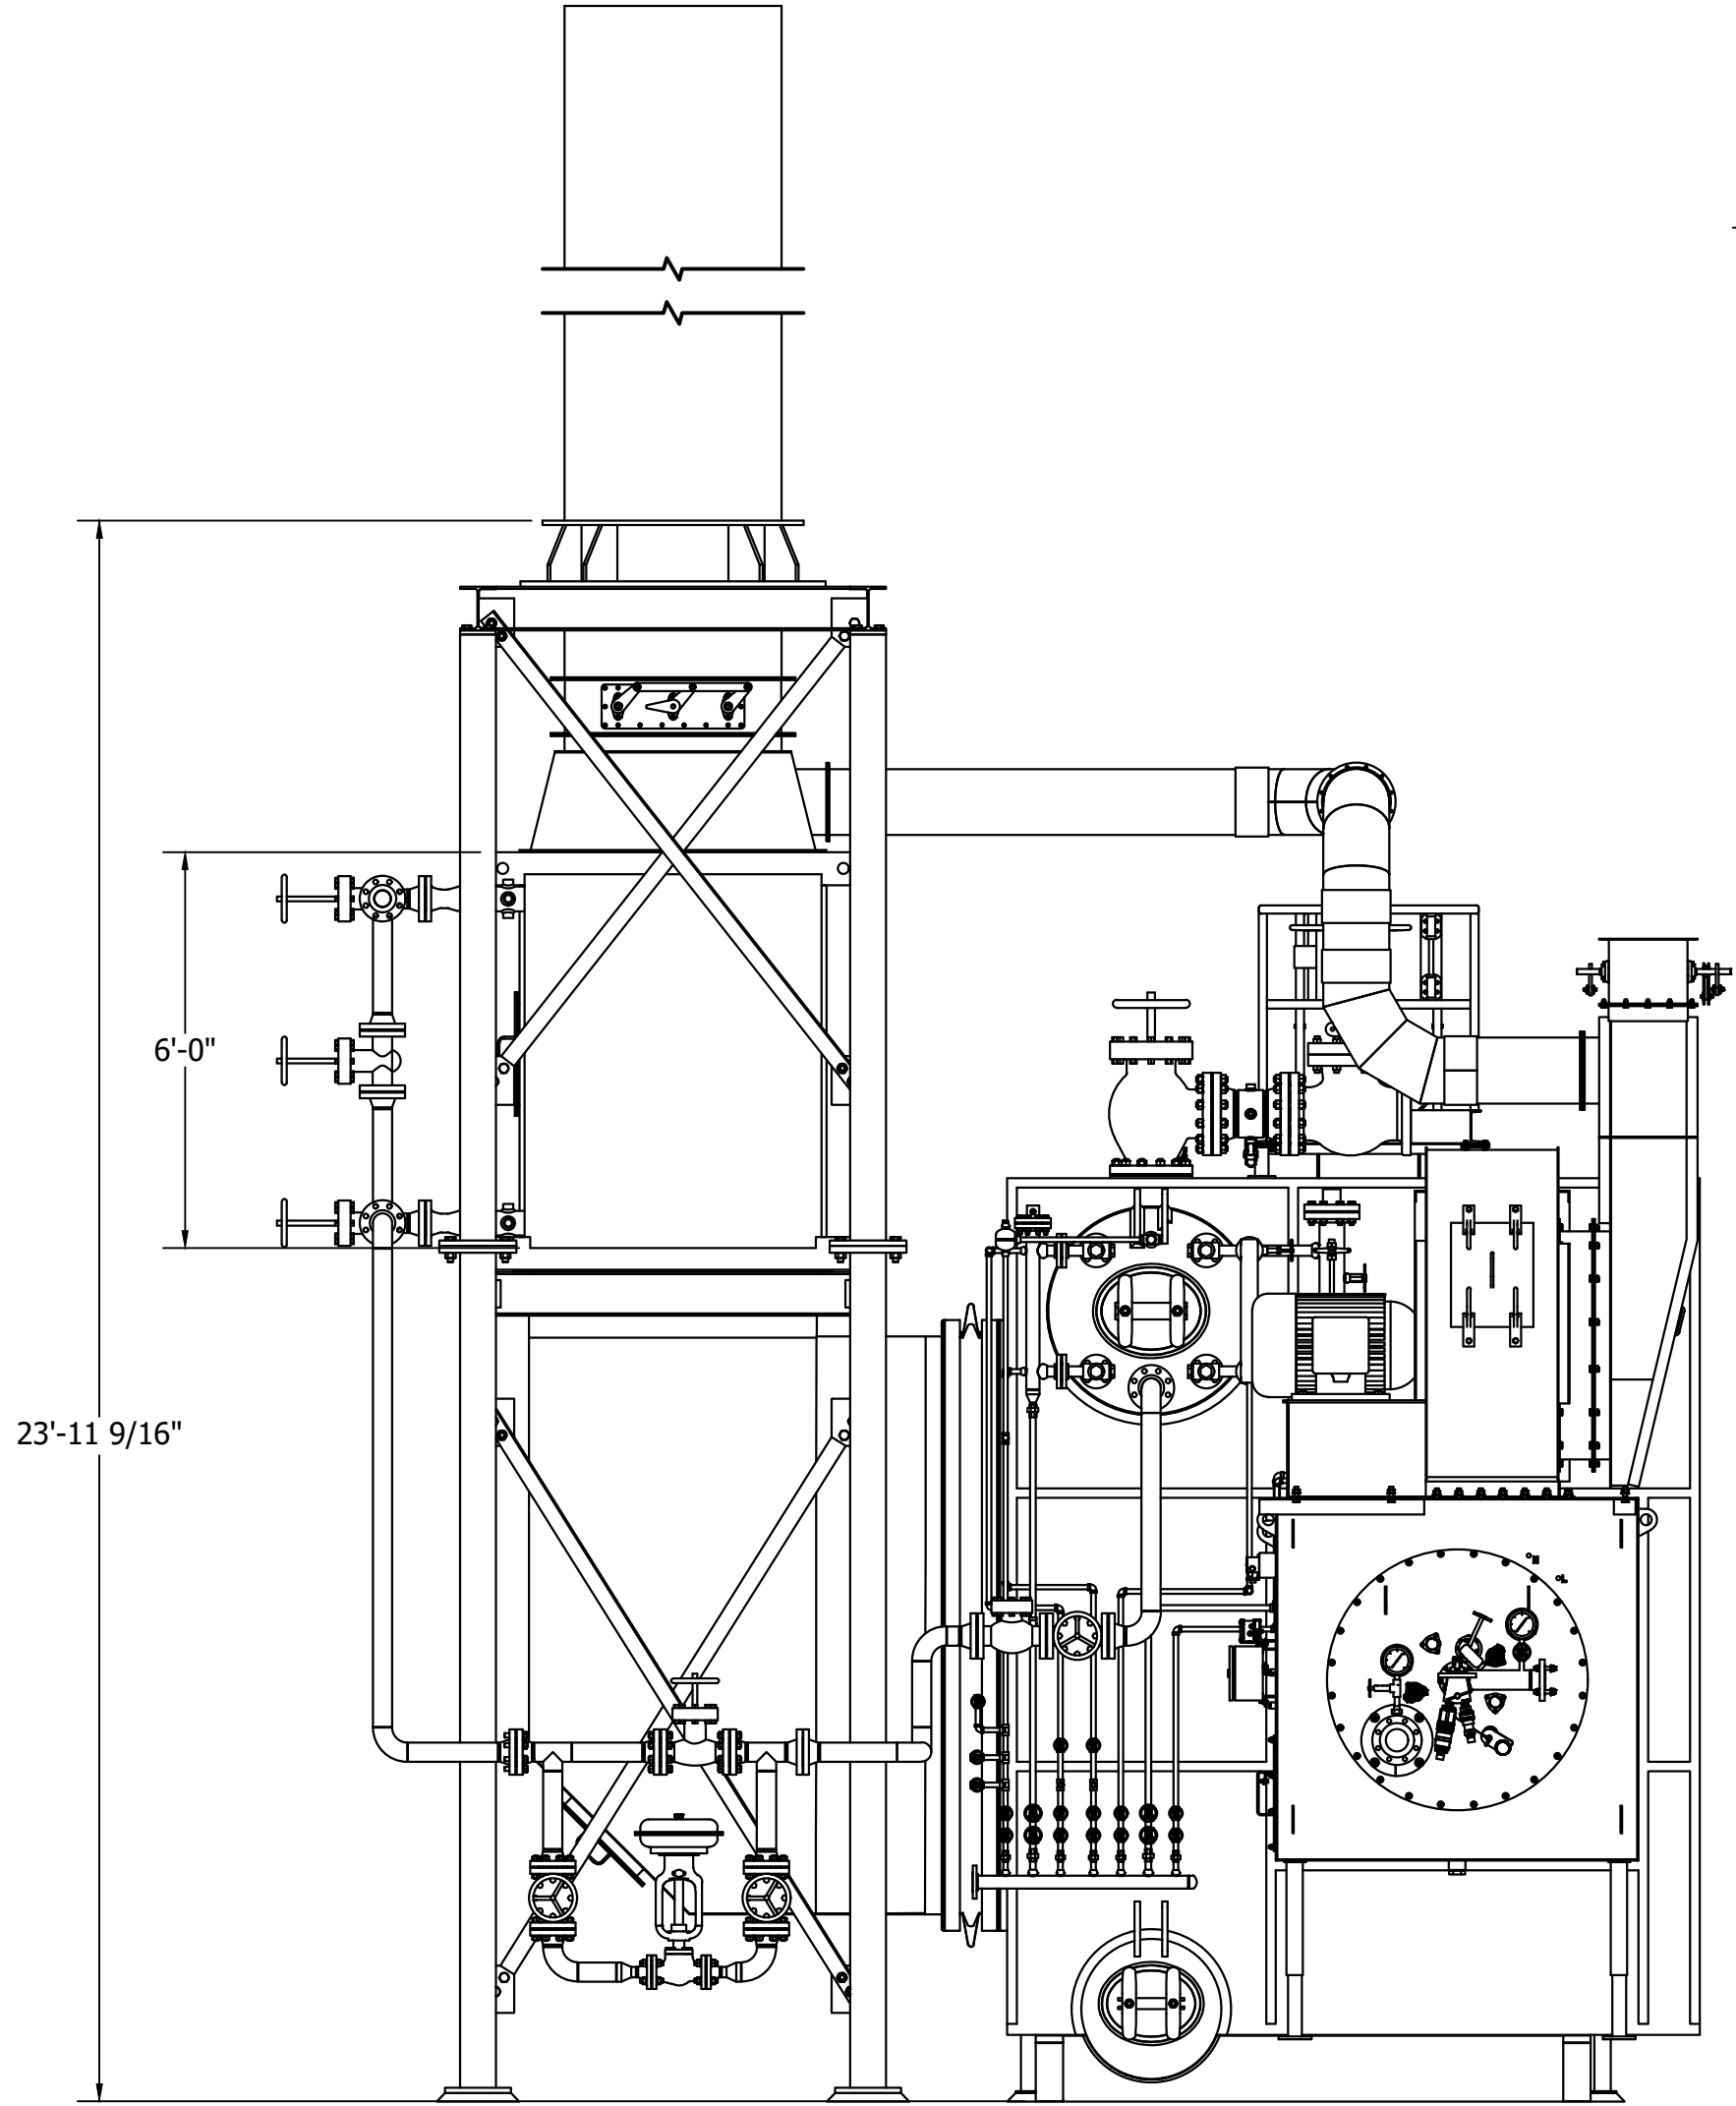

FRONT ELEVATION

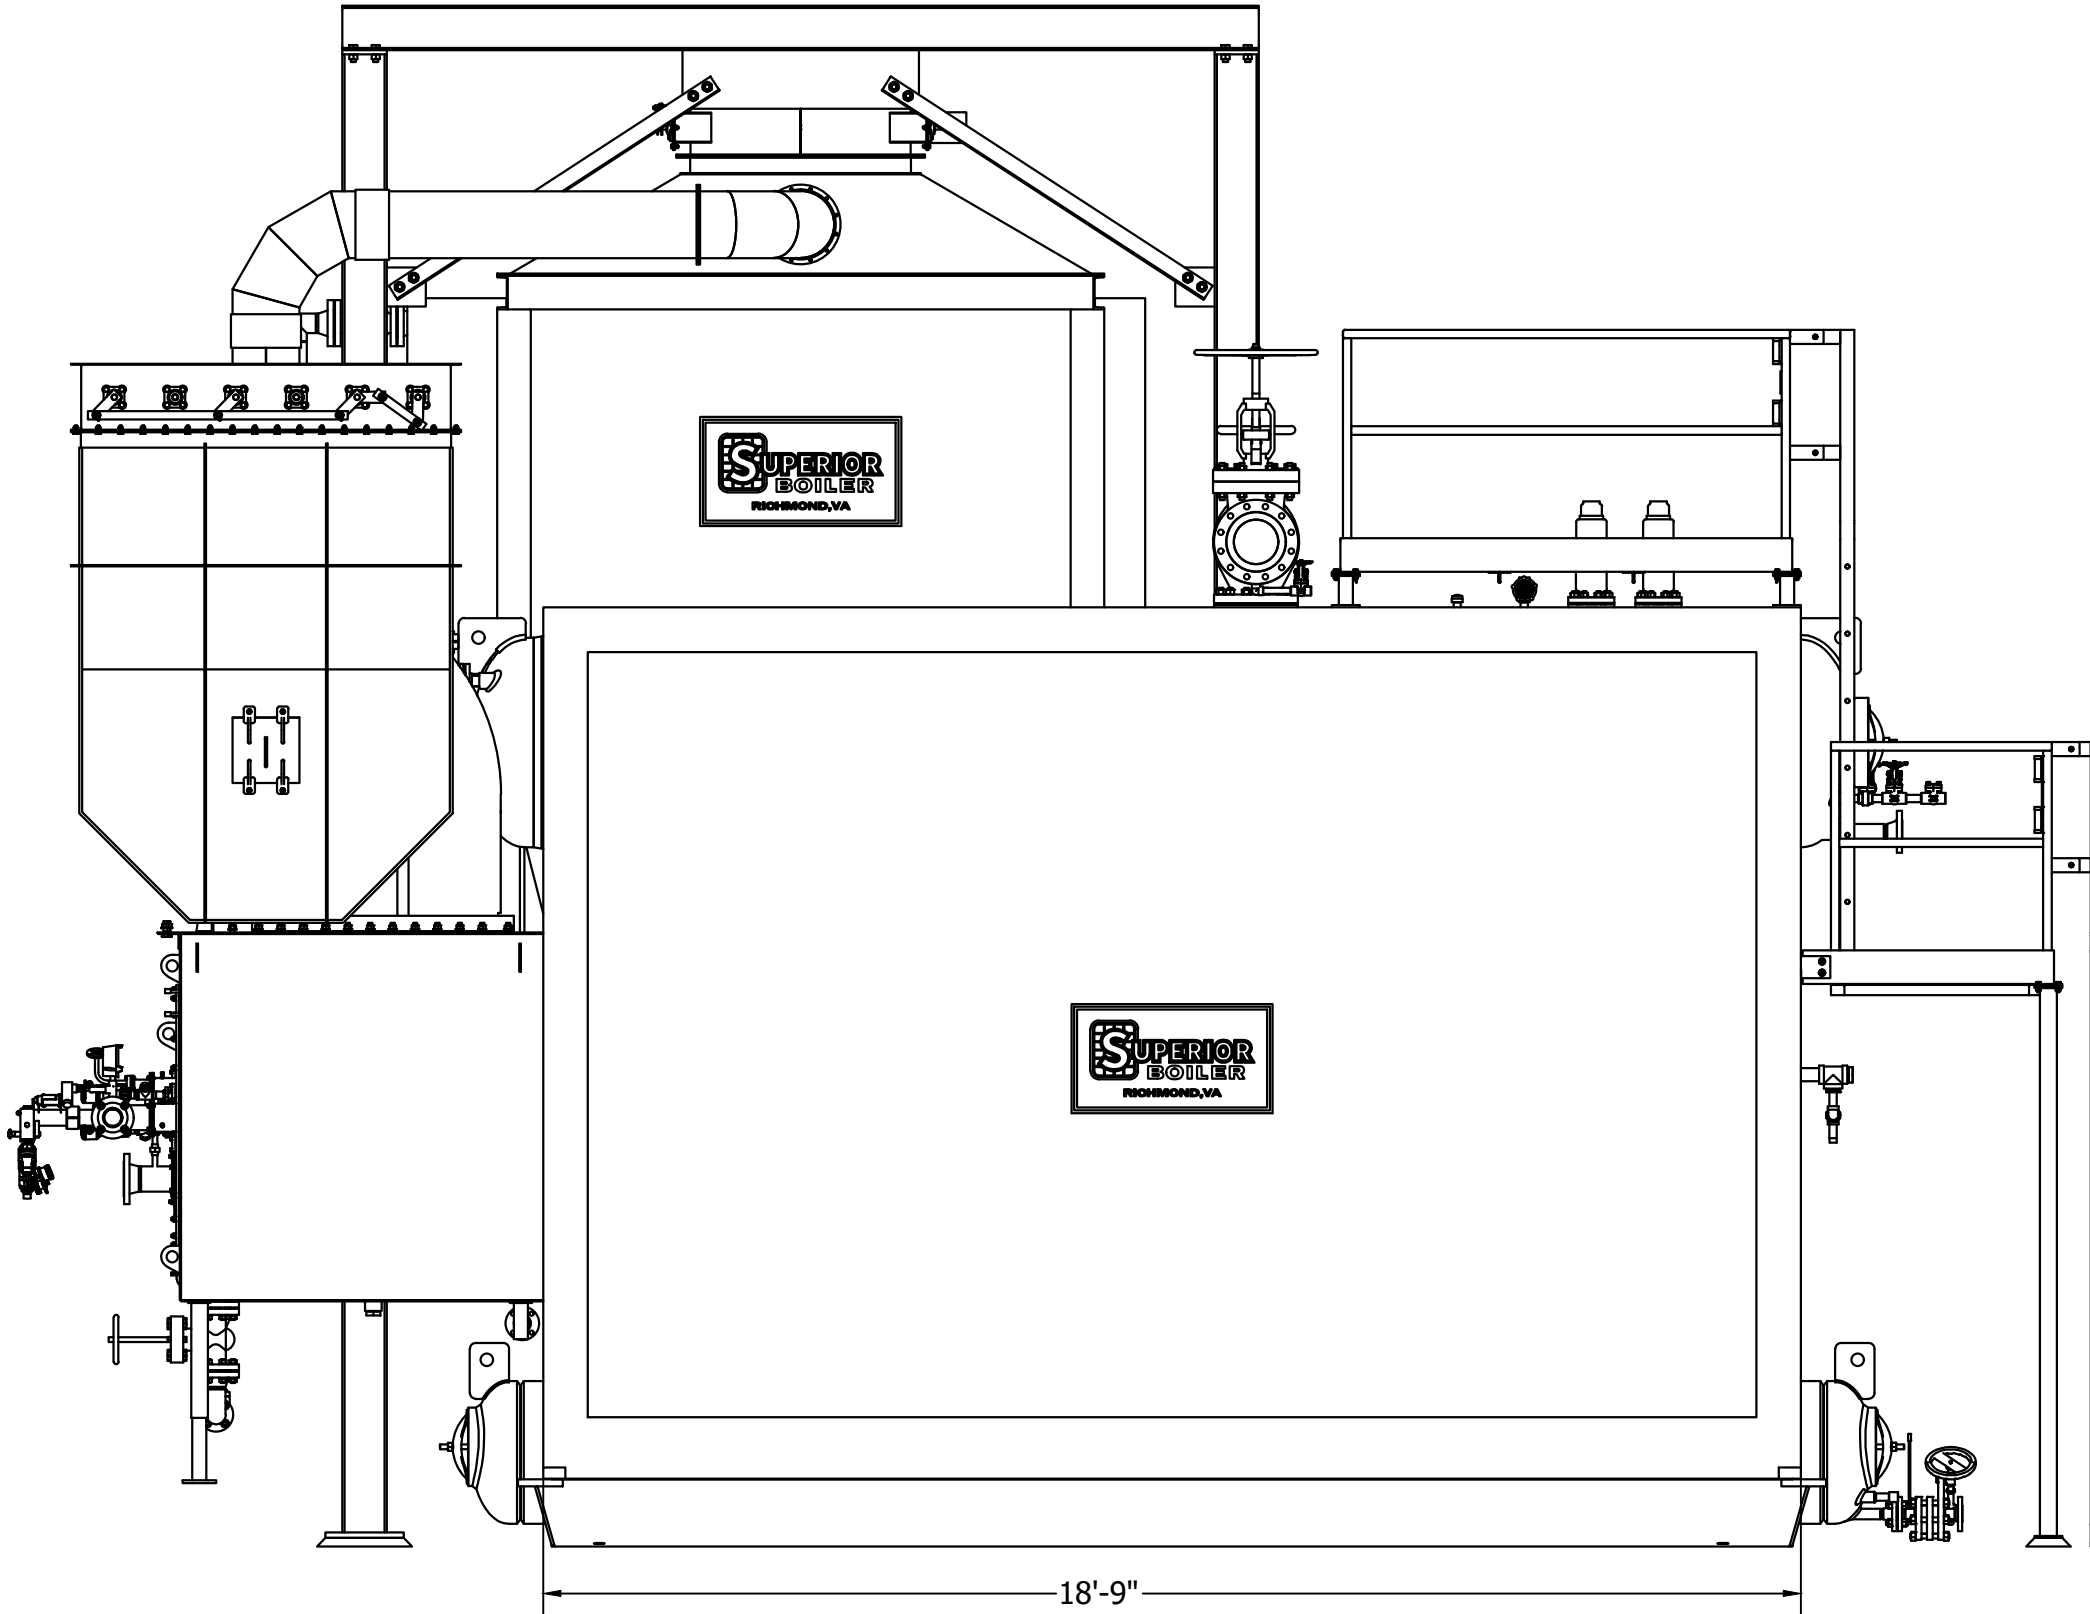


SIDE ELEVATION

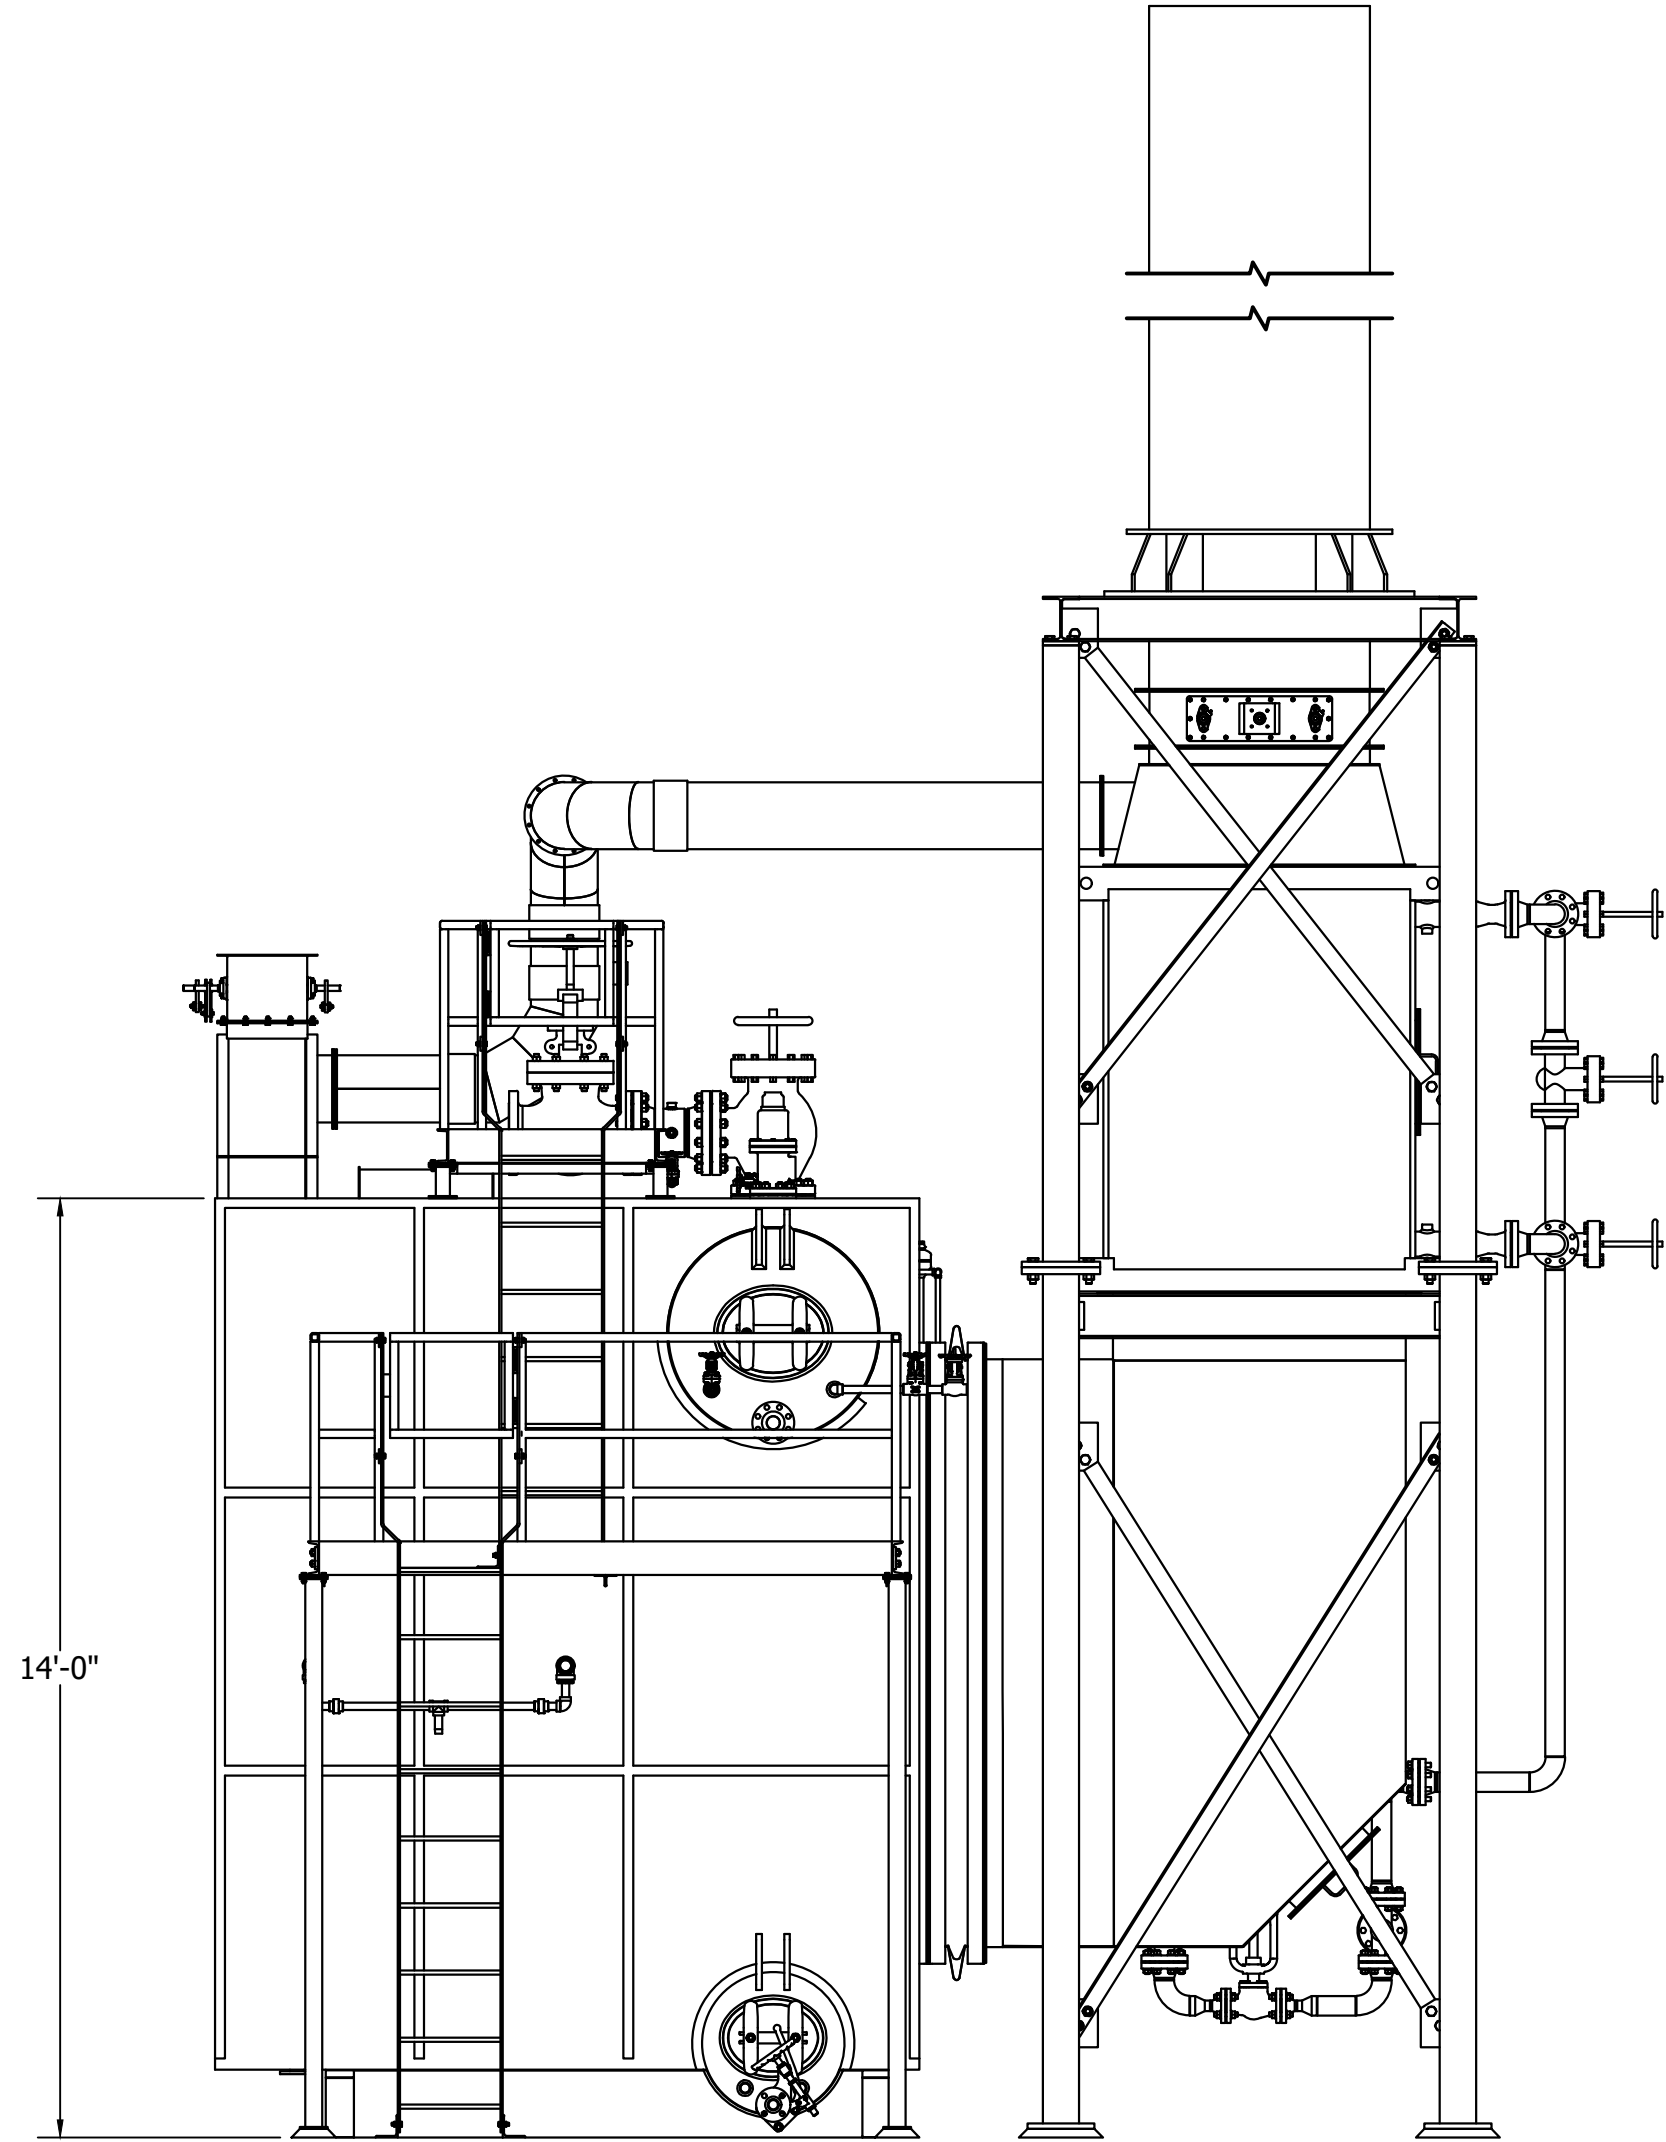

REAR ELEVATION

NOTICE: THIS DRAWING AND ALL FEATURES SEPARATELY OR COLLECTIVELY DISCLOSED THEREBY OR EMBODIED THEREIN ARE THE PROPERTY OF SUPERIOR BOILER, LLC. THE DRAWING SHALL NOT BE REPRODUCED OR COPIED, AND MUST BE RETURNED IMMEDIATELY UPON REQUEST. NO INFORMATION EMBODIED THEREIN SHALL BE COMMUNICATED, DISCLOSED, OR USED IN ANY MANNER, IN WHOLE OR IN PART EXCEPT AS AND TO EXTEND PREVIOUSLY EXPRESSLY AUTHORIZED IN WRITING BY THE COMPANY.

REV. #		REVISION DESCRIPTION		DATE	DRAWN	APPR.	P.M.	<div><div><div>SUPERIOR BOILER</div><div>ALL DRAWING DIMENSIONS ARE ROUNDED TO 1/16" (0.0625") UNLESS OTHERWISE SPECIFIED.</div><div>REFERENCE STANDARD S.B. TOLERANCE DOCUMENT FOR ALLOWABLE SHOP CONSTRUCTION TOLERANCES</div></div><div><div>3524 E. 4TH AVE. HUTCHINSON,KS, 67501-1960</div><div>PHONE: 1-620-662-6693</div><div>WWW.SUPERIORBOILER.COM</div></div><div><div></div></div></div>	
QC STAMP		PRODUCTION STAMP		ENGINEERING STAMP		DRAWING NAME			
						GENERAL ARRANGEMENT			
						CONTRACTOR		PROJECT	
						DRAWN BY MS		APPR. BY DATE 12/16/2022	
						PROJ. MGR. DATE		MODEL NUMBER 60-D-XXX DRAWING NUMBER	
						SCALE 3/8" = 1'		REV. # 0	
						SIZE D			