




CONNECTION SCHEDULE	
CONNECTION	SIZE & DESCRIPTION
MAIN STEAM OUTLET	
MAIN STEAM SPOOL DRAIN	
SAFETY VALVE(S)	
STEAM DRUM VENT	
FEEDWATER INLET	
FEEDWATER STATION DRAIN	
CHEMICAL FEED	
INTERMITTENT BLOWDOWN	
CONTINUOUS BLOWDOWN	
HEATING COIL(S)	
OBSERVATION PORT	
FRONT TRIM DRAIN	
ECONOMIZER VENT	
ECONOMIZER SRV	
ECONOMIZER DRAIN	

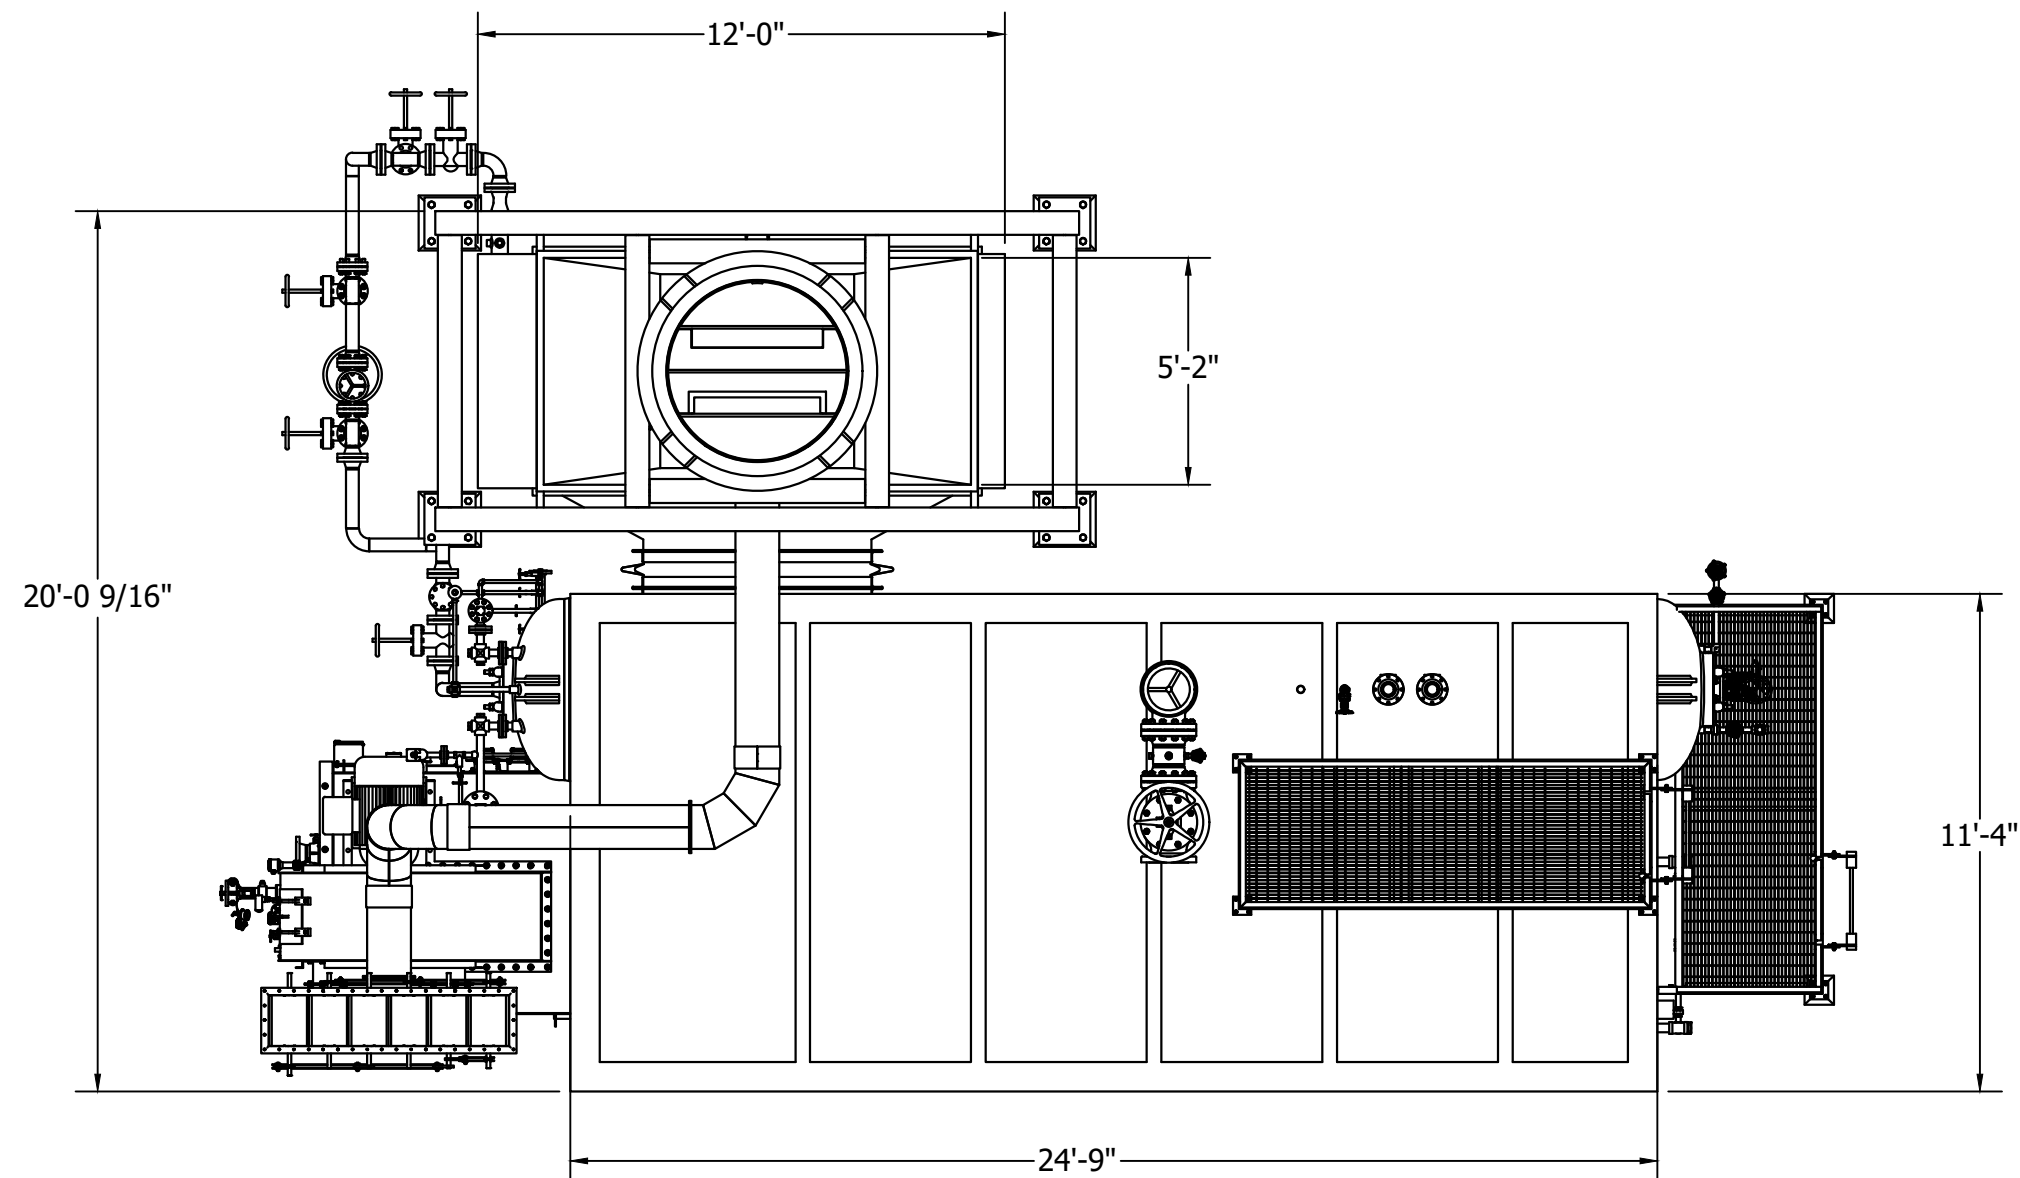


### PLAN VIEW

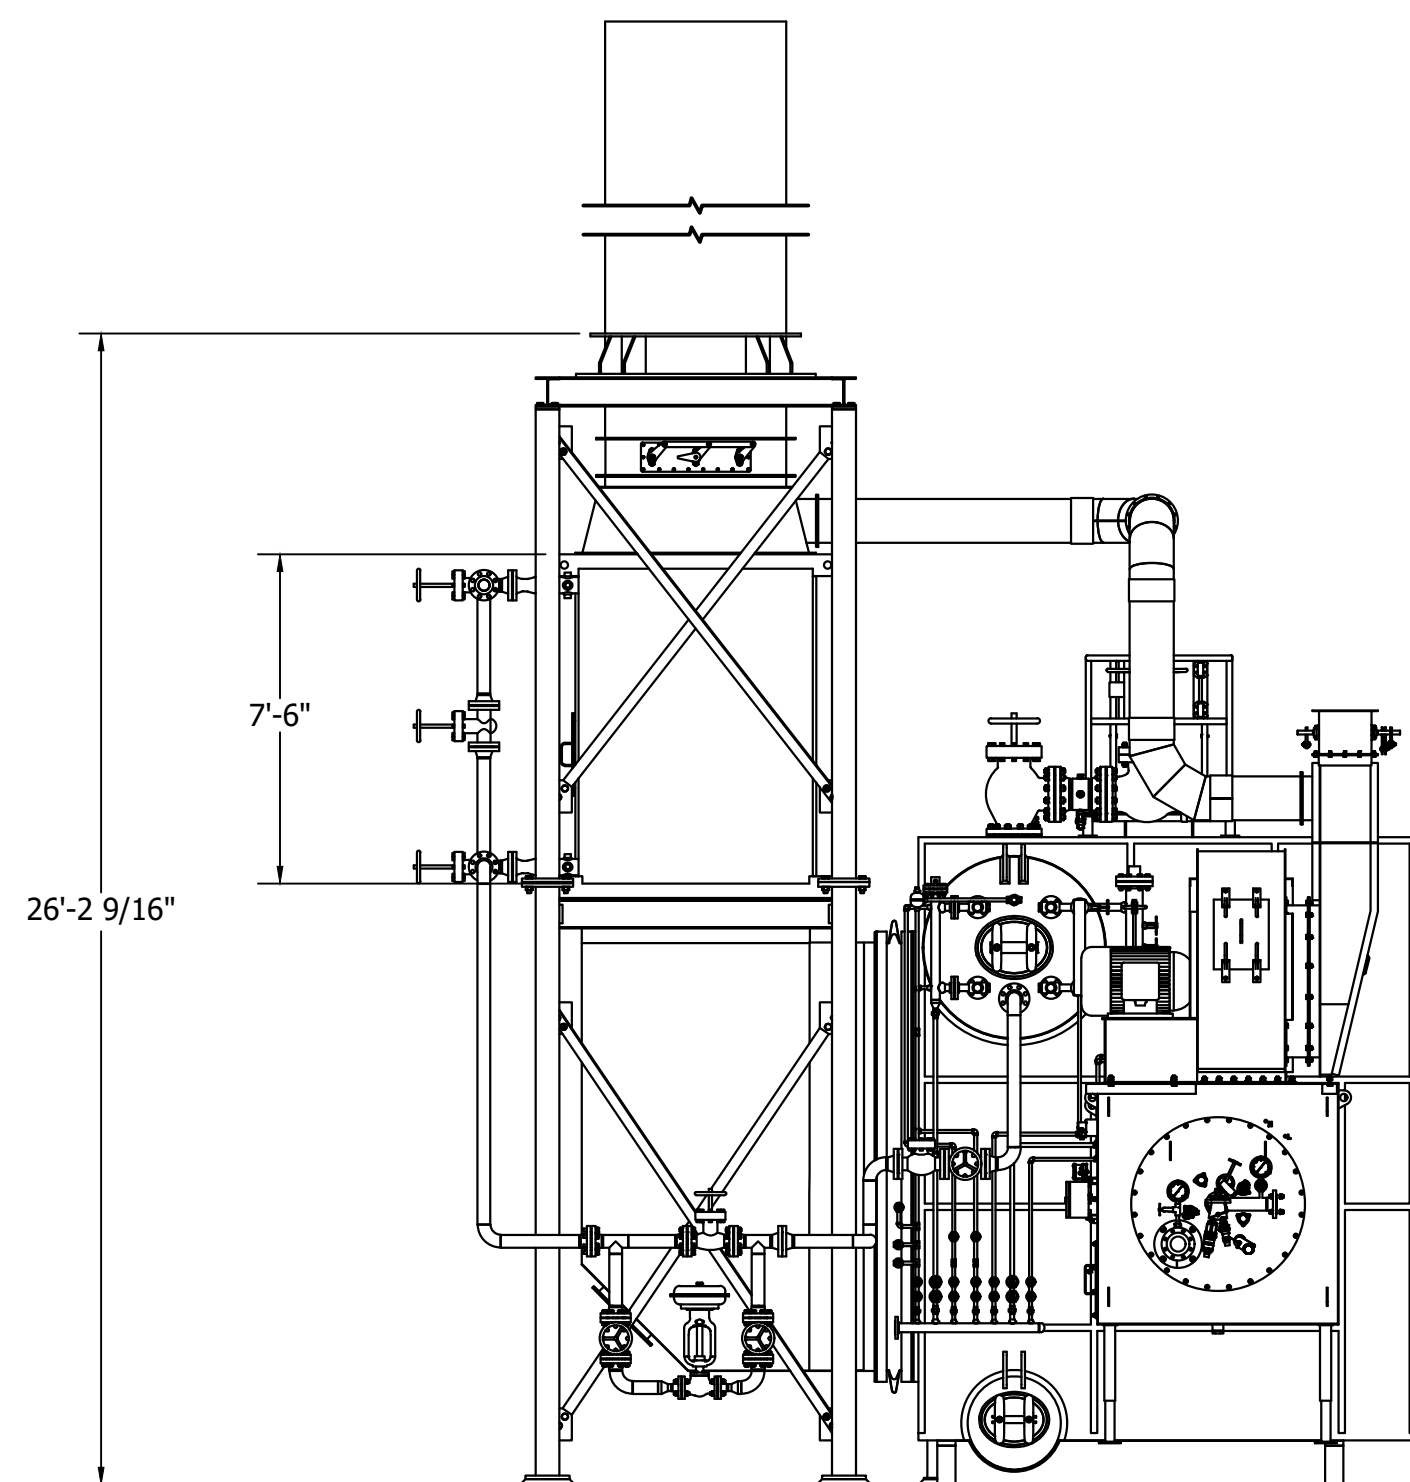

### FRONT ELEVATION

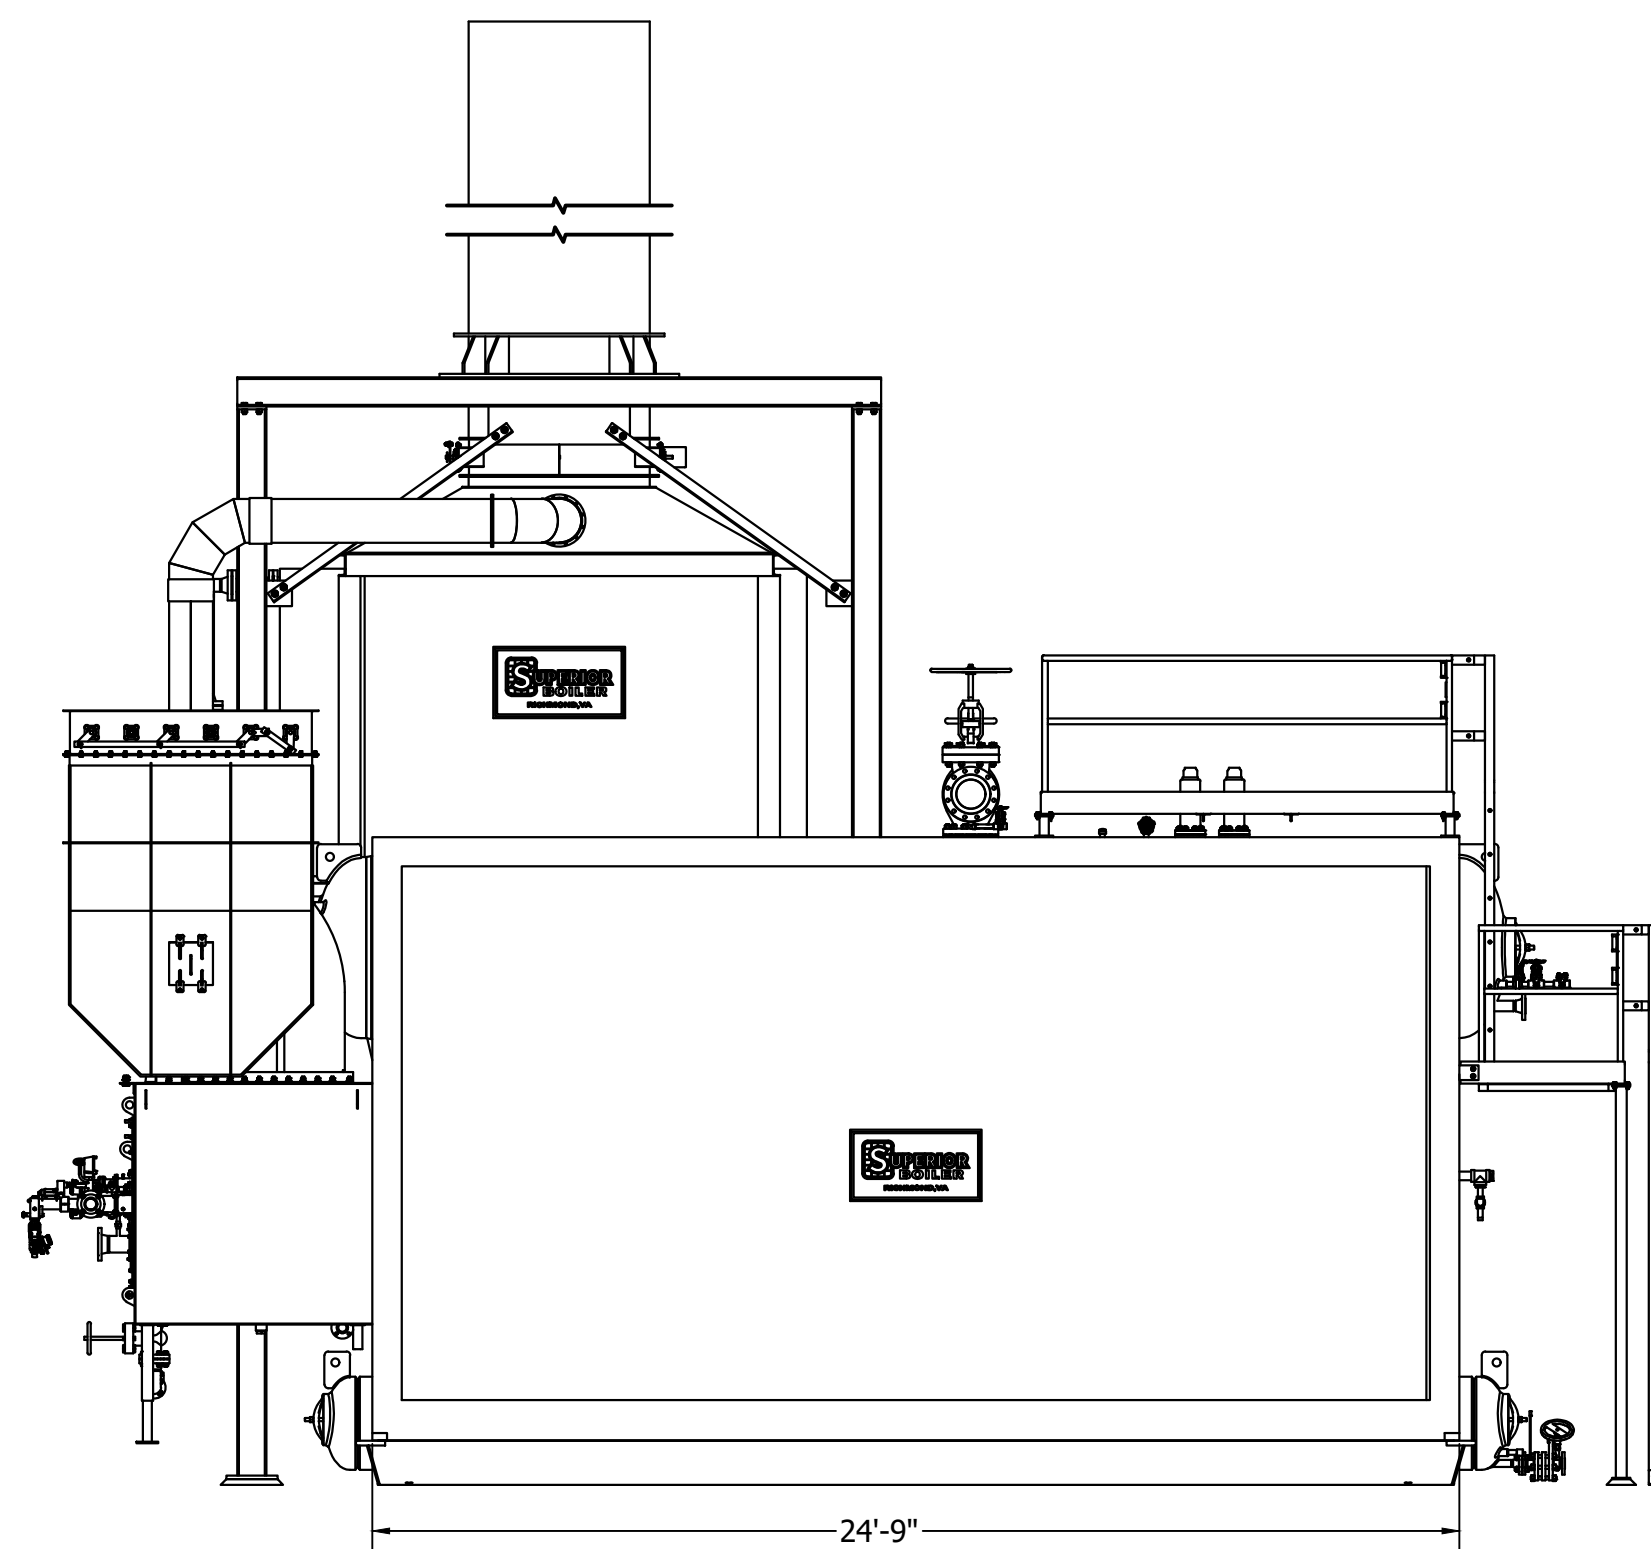

### SIDE ELEVATION

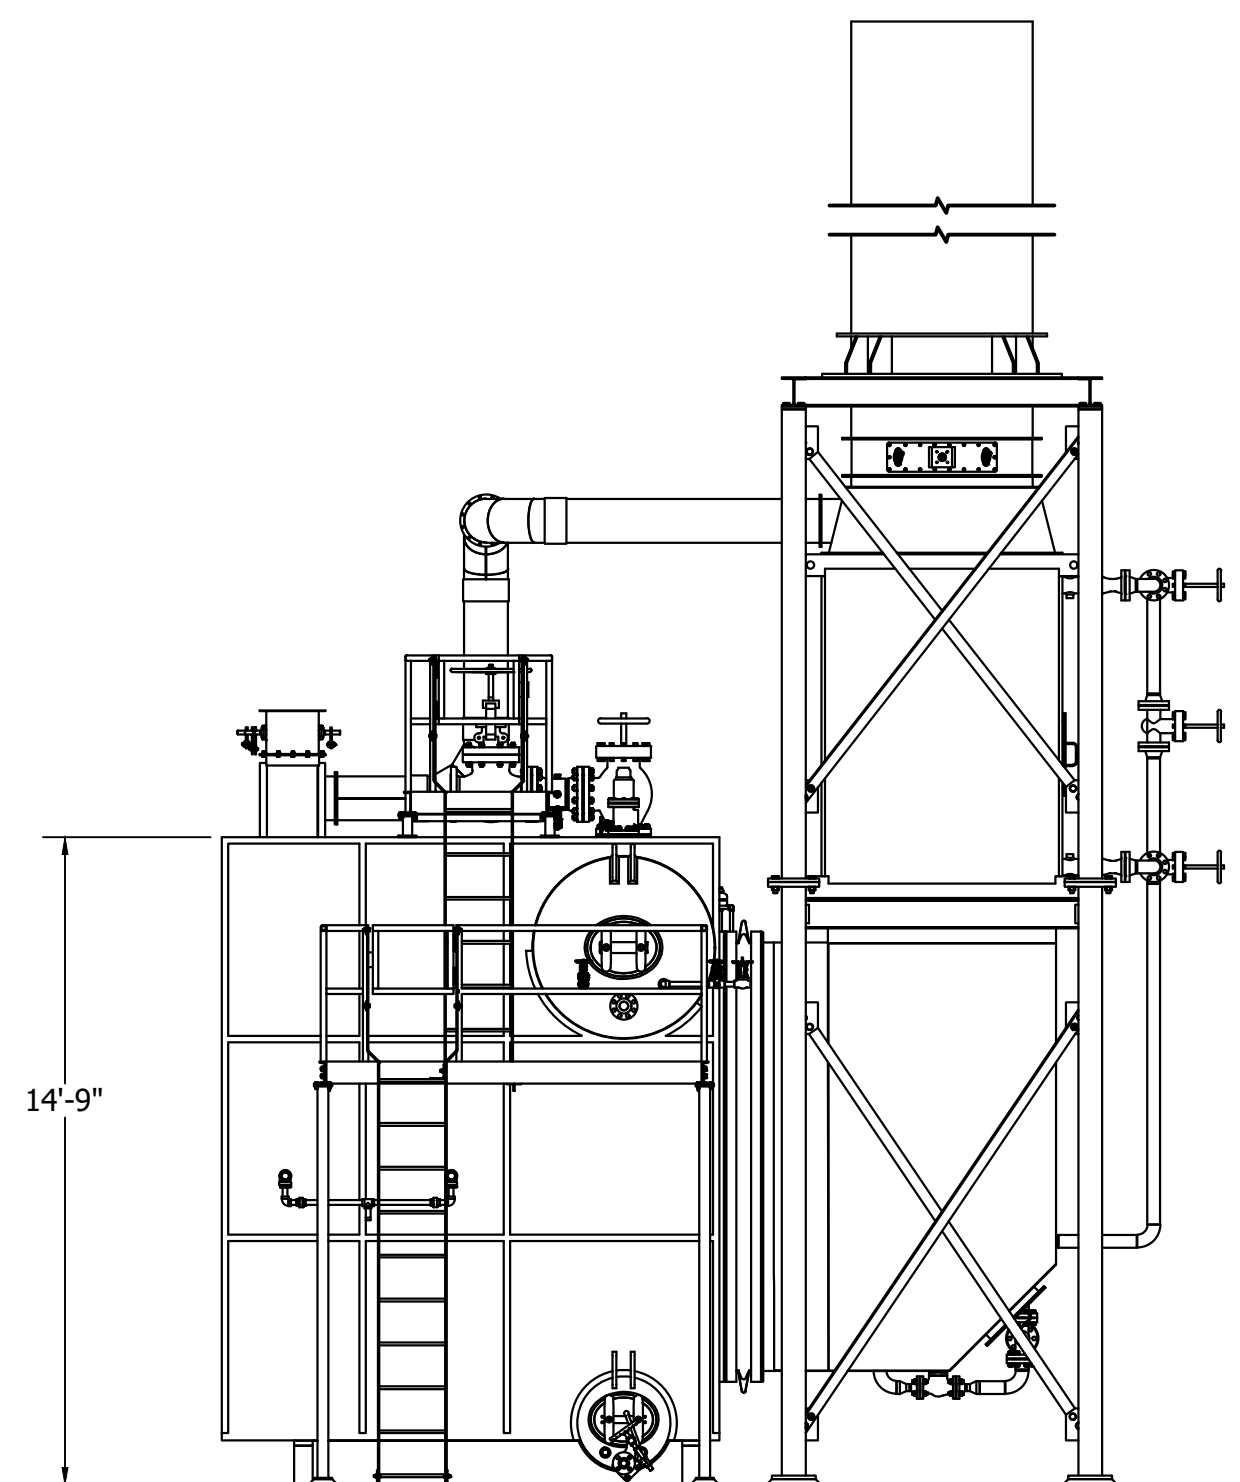

### REAR ELEVATION

# PRELIMINARY

BOILER DATA	
MODEL NUMBER	90-D-xxx
GROSS CAPACITY	90,000 LB/HR
DESIGN PRESSURE	
OPERATING PRESSURE	
SATURATED STEAM TEMP.	
FEEDWATER TEMP.	
ELEVATION	<1,000 FT
FUEL	NAT. GAS

**NOTES:**

1. DESIGNED & FABRICATED ACCORDING TO ASME SECTION 1, FOR POWER BOILERS AND PRESSURE VESSELS 2021 EDITION.

REV. #	REVISION DESCRIPTION	DATE	DRAWN	APPR.	P.M.
QC STAMP	PRODUCTION STAMP	ENGINEERING STAMP			

NOTICE: THIS DRAWING AND ALL FEATURES SEPARATELY OR COLLECTIVELY DISCLOSED THEREBY OR EMBODIED THEREIN ARE THE PROPERTY OF SUPERIOR BOILER, LLC. THE DRAWING SHALL NOT BE REPRODUCED OR COPIED, AND MUST BE RETURNED IMMEDIATELY UPON REQUEST. NO INFORMATION EMBODIED THEREIN SHALL BE COMMUNICATED, DISCLOSED, OR USED IN ANY MANNER, IN WHOLE OR IN PART EXCEPT AS AND TO EXTEND PREVIOUSLY EXPRESSLY AUTHORIZED IN WRITING BY THE COMPANY.



3524 E. 4TH AVE. | PHONE: 1-620-662-6693  
HUTCHINSON KS 67501-1960



ALL DRAWING DIMENSIONS  
ARE ROUNDED TO  
1/16" (0.0625") UNLESS  
OTHERWISE SPECIFIED.

5	DRAWING NAME
---	--------------

## GENERAL ARRANGEMENT

1710 OTHERWISE SPECIFIED.  REFERENCE STANDARD S.B. TOLERANCE DOCUMENT FOR ALLOWABLE SHOP CONSTRUCTION TOLERANCES	CONTRACTOR			PROJECT	
	DRAWN BY MS	APPR. BY	PROJ. MGR.	MODEL NUMBER 90-D-XXX	SCALE 1/4" = 1'
	DATE 12/19/2022	DATE	DATE	DRAWING NUMBER	SIZE D