


CONNECTION SCHEDULE	
CONNECTION	SIZE & DESCRIPTION
MAIN STEAM OUTLET	
MAIN STEAM SPOOL DRAIN	
SAFETY VALVE(S)	
STEAM DRUM VENT	
FEEDWATER INLET	
FEEDWATER STATION DRAIN	
CHEMICAL FEED	
INTERMITTENT BLOWDOWN	
CONTINUOUS BLOWDOWN	
HEATING COIL(S)	
OBSERVATION PORT	
FRONT TRIM DRAIN	
ECONOMIZER VENT	
ECONOMIZER SRV	
ECONOMIZER DRAIN	

PRELIMINARY


BOILER DATA	
MODEL NUMBER	100-DS-xxx
GROSS CAPACITY	100,000 LB/HR
DESIGN PRESSURE	
OPERATING PRESSURE	
SATURATED STEAM TEMP.	
FEEDWATER TEMP.	
ELEVATION	<1,000 FT
FUEL	NAT. GAS

NOTES:


1. DESIGNED & FABRICATED ACCORDING TO ASME SECTION 1, FOR POWER BOILERS AND PRESSURE VESSELS 2021 EDITION.

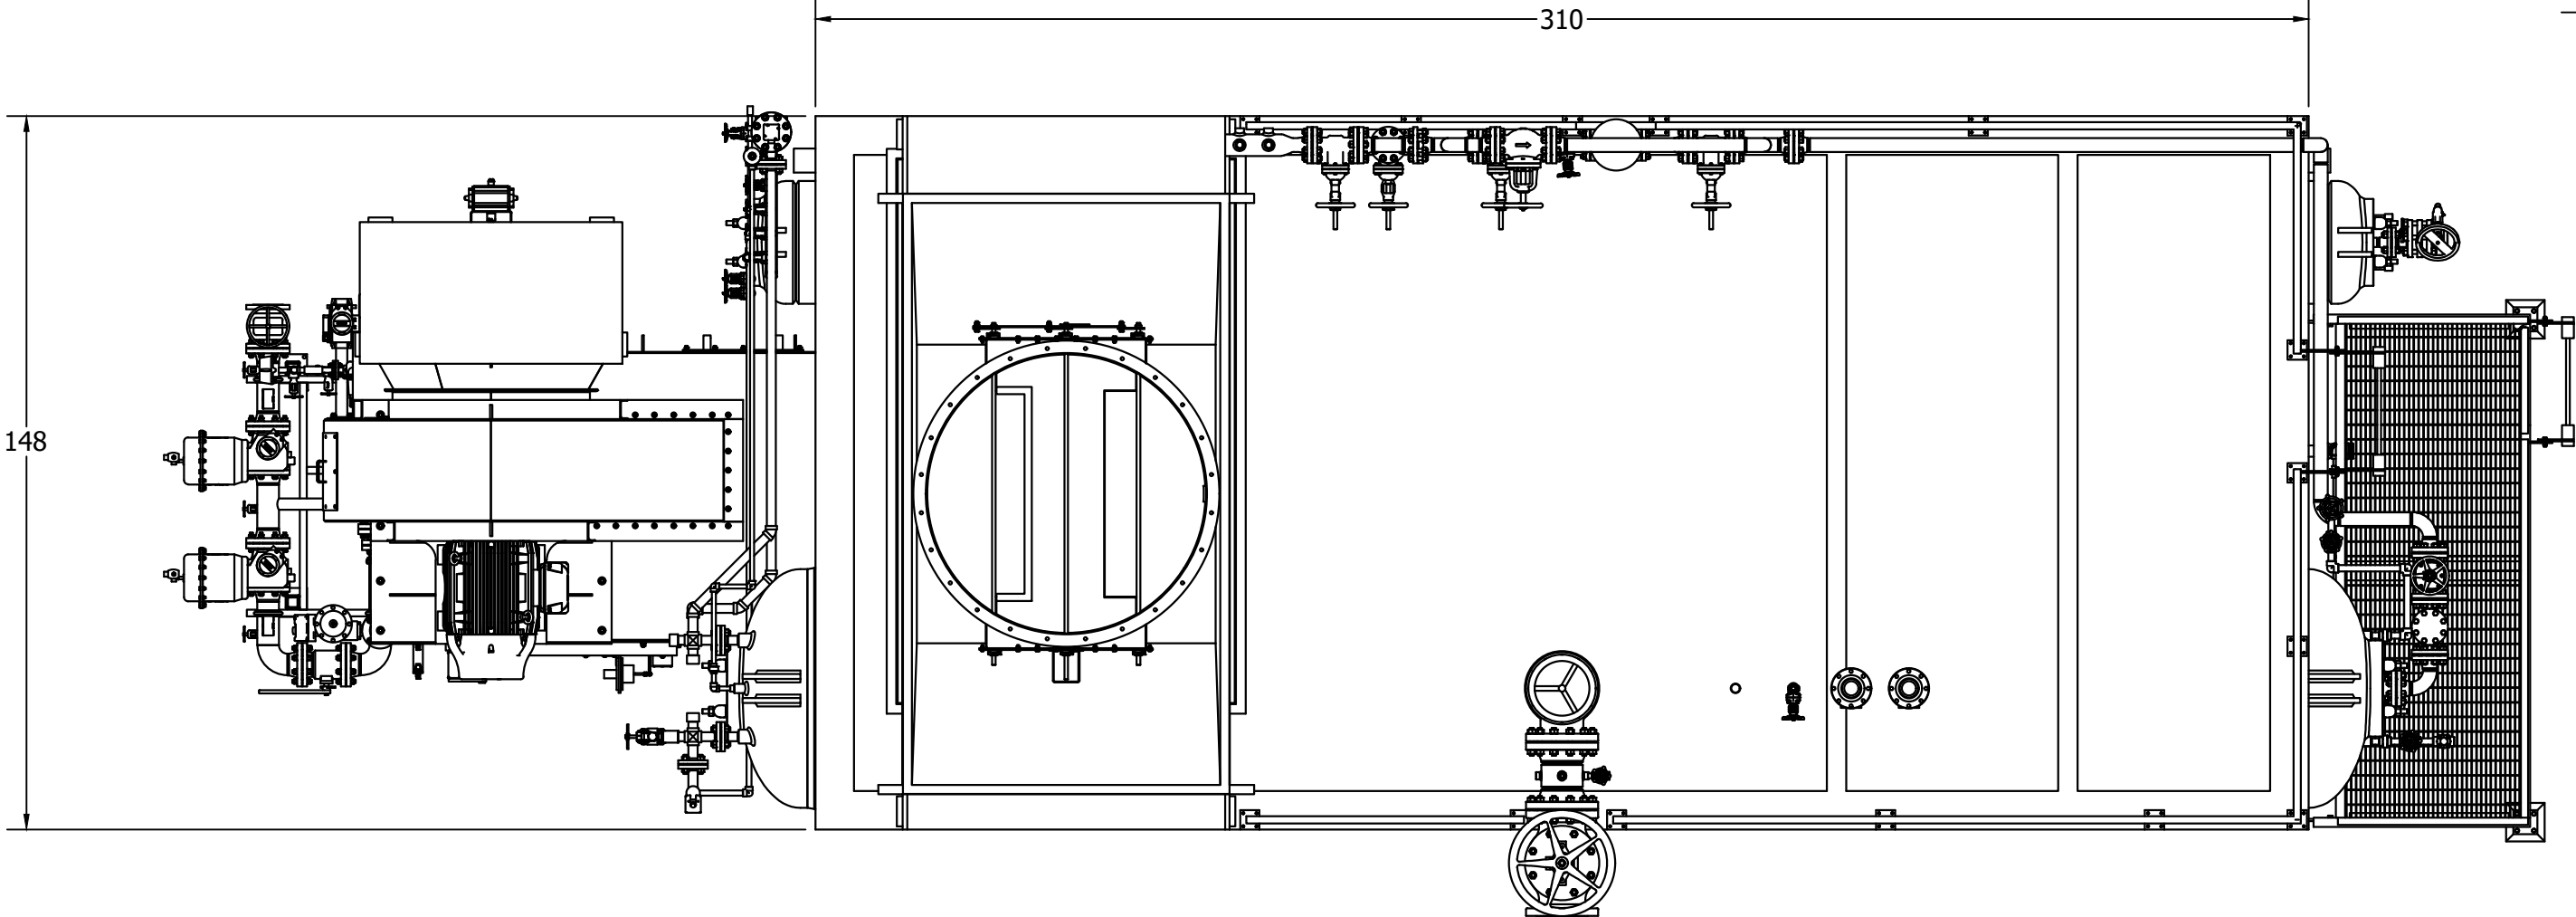


PLAN VIEW

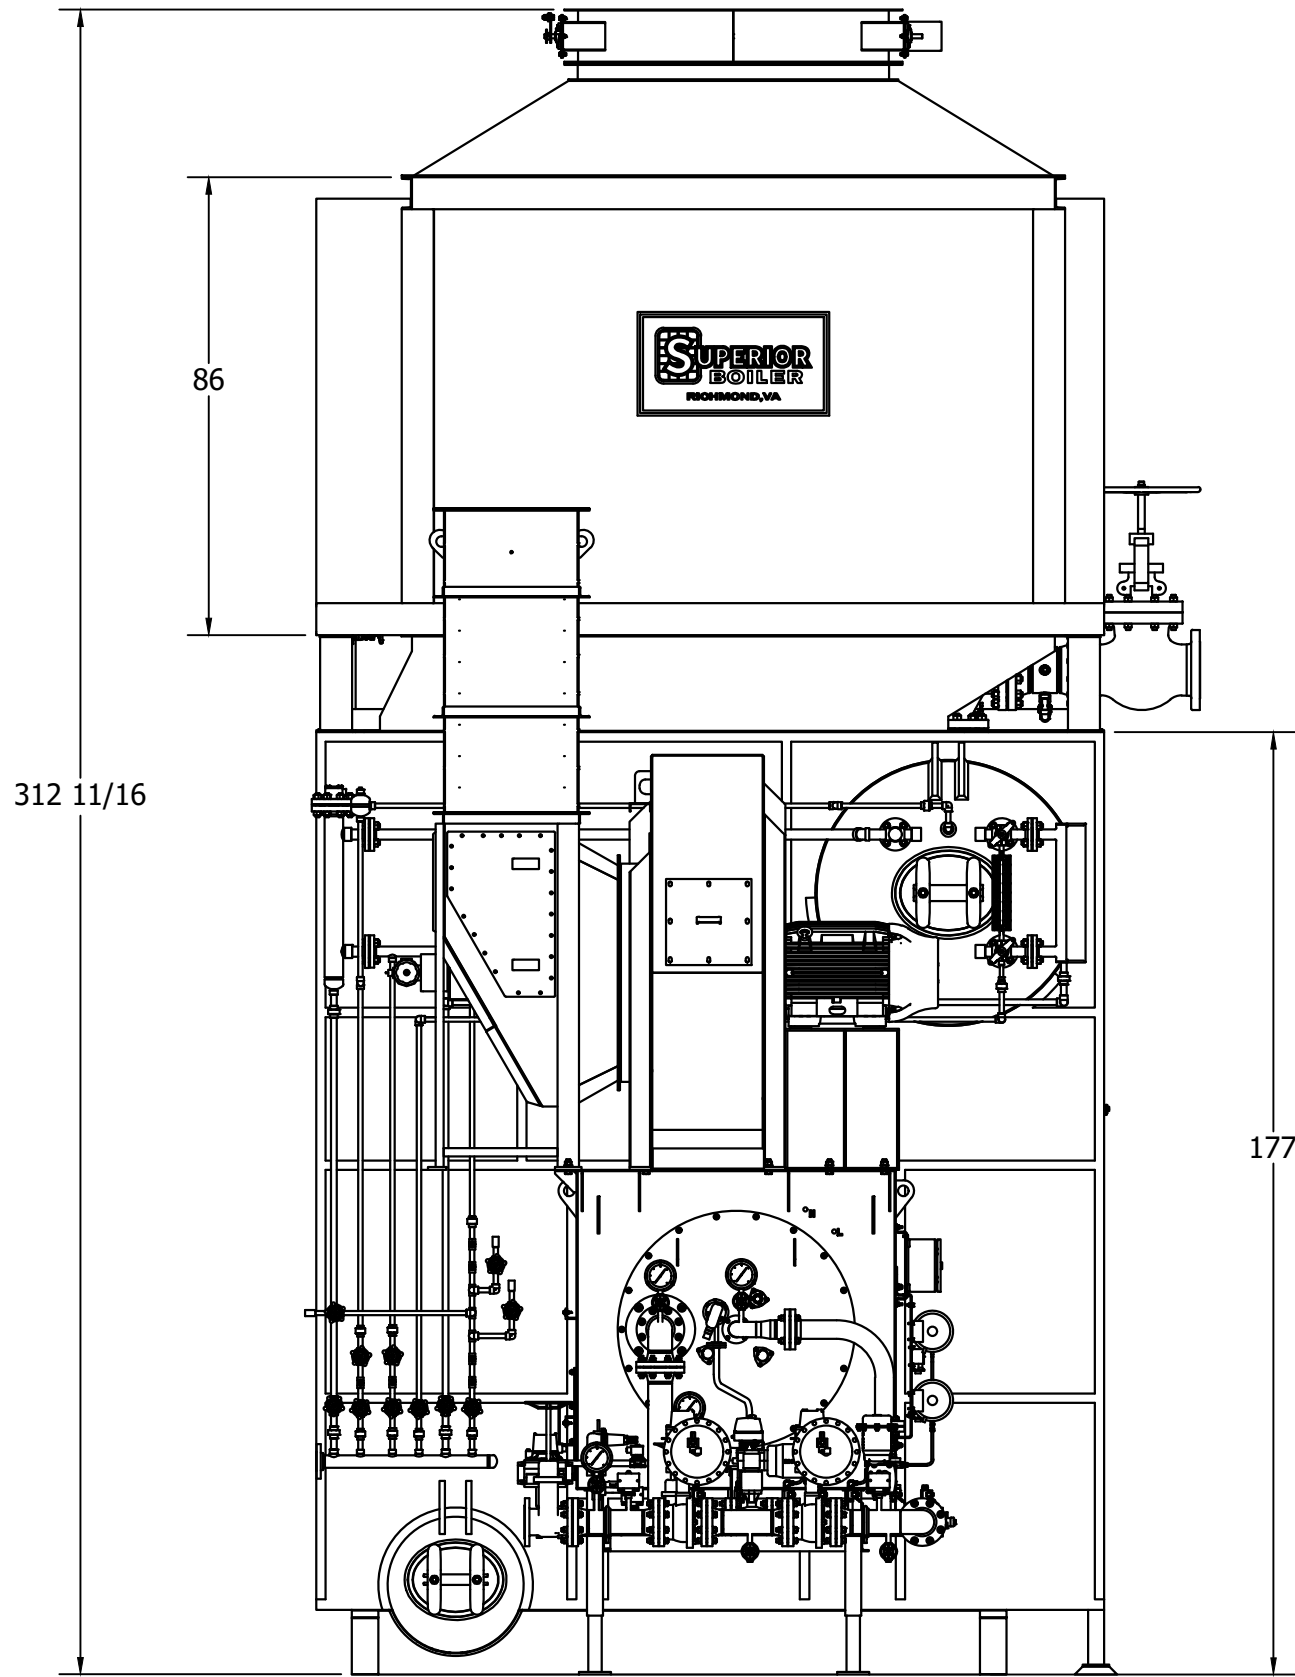

FRONT ELEVATION

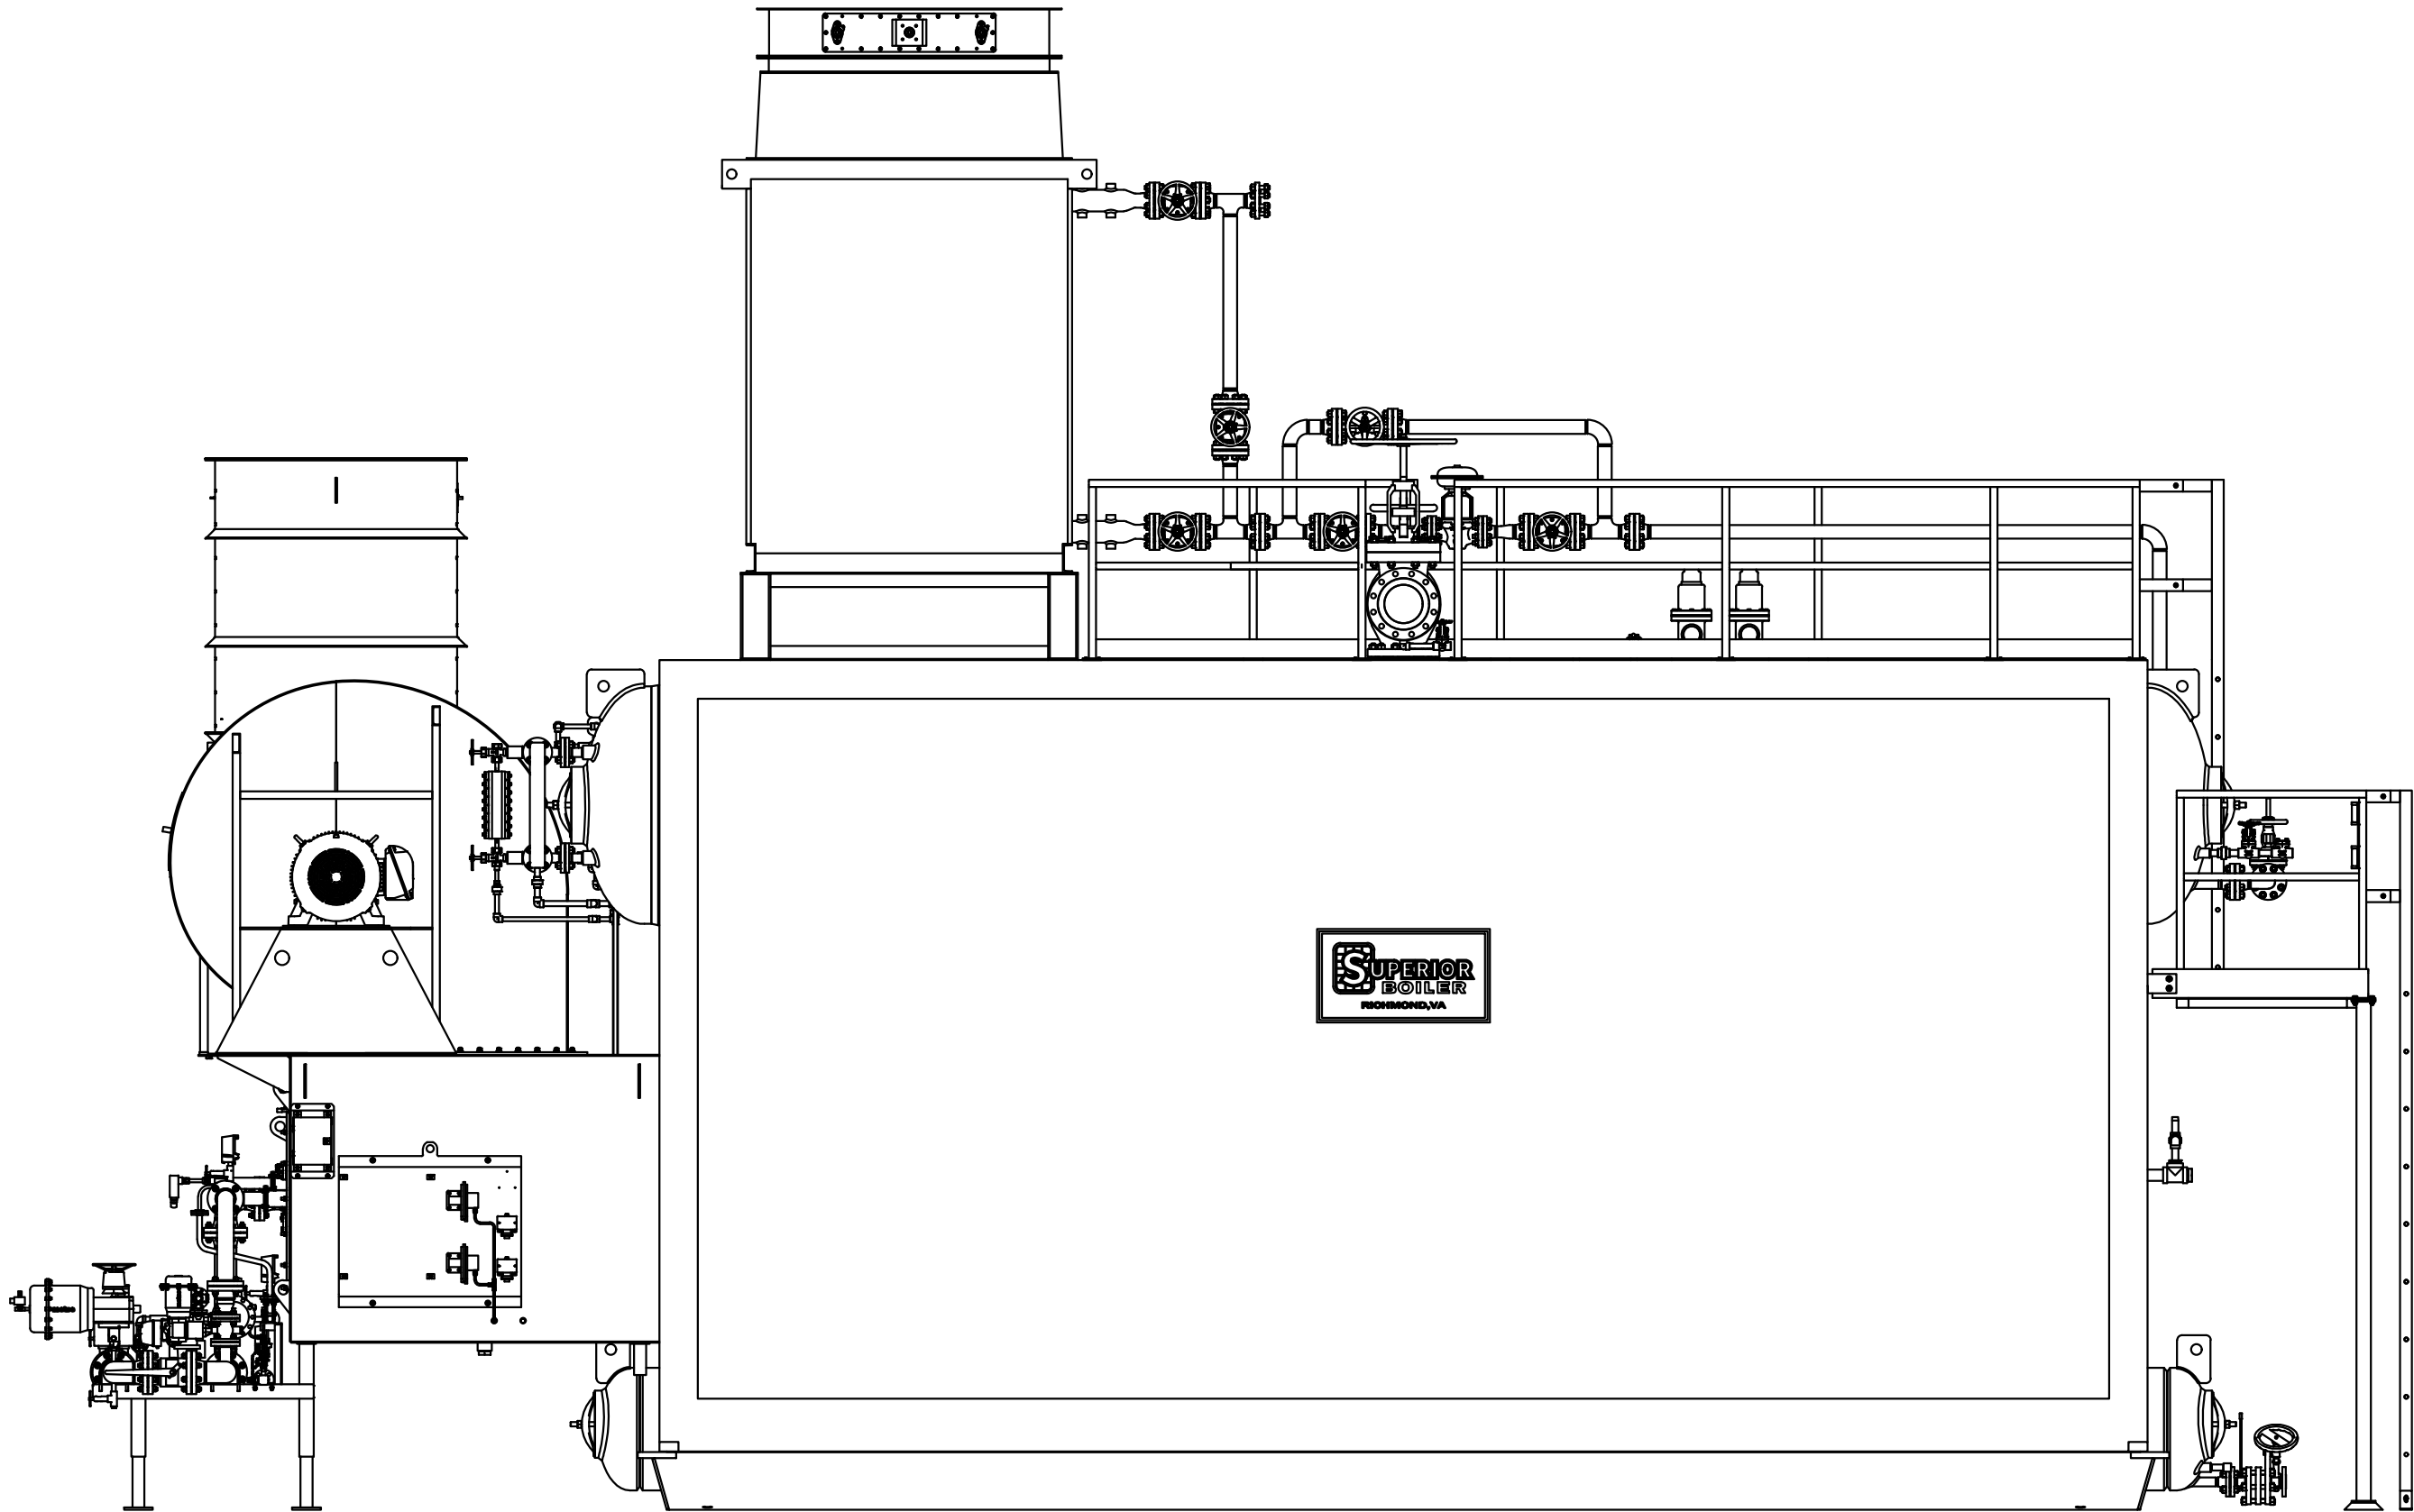

SIDE ELEVATION

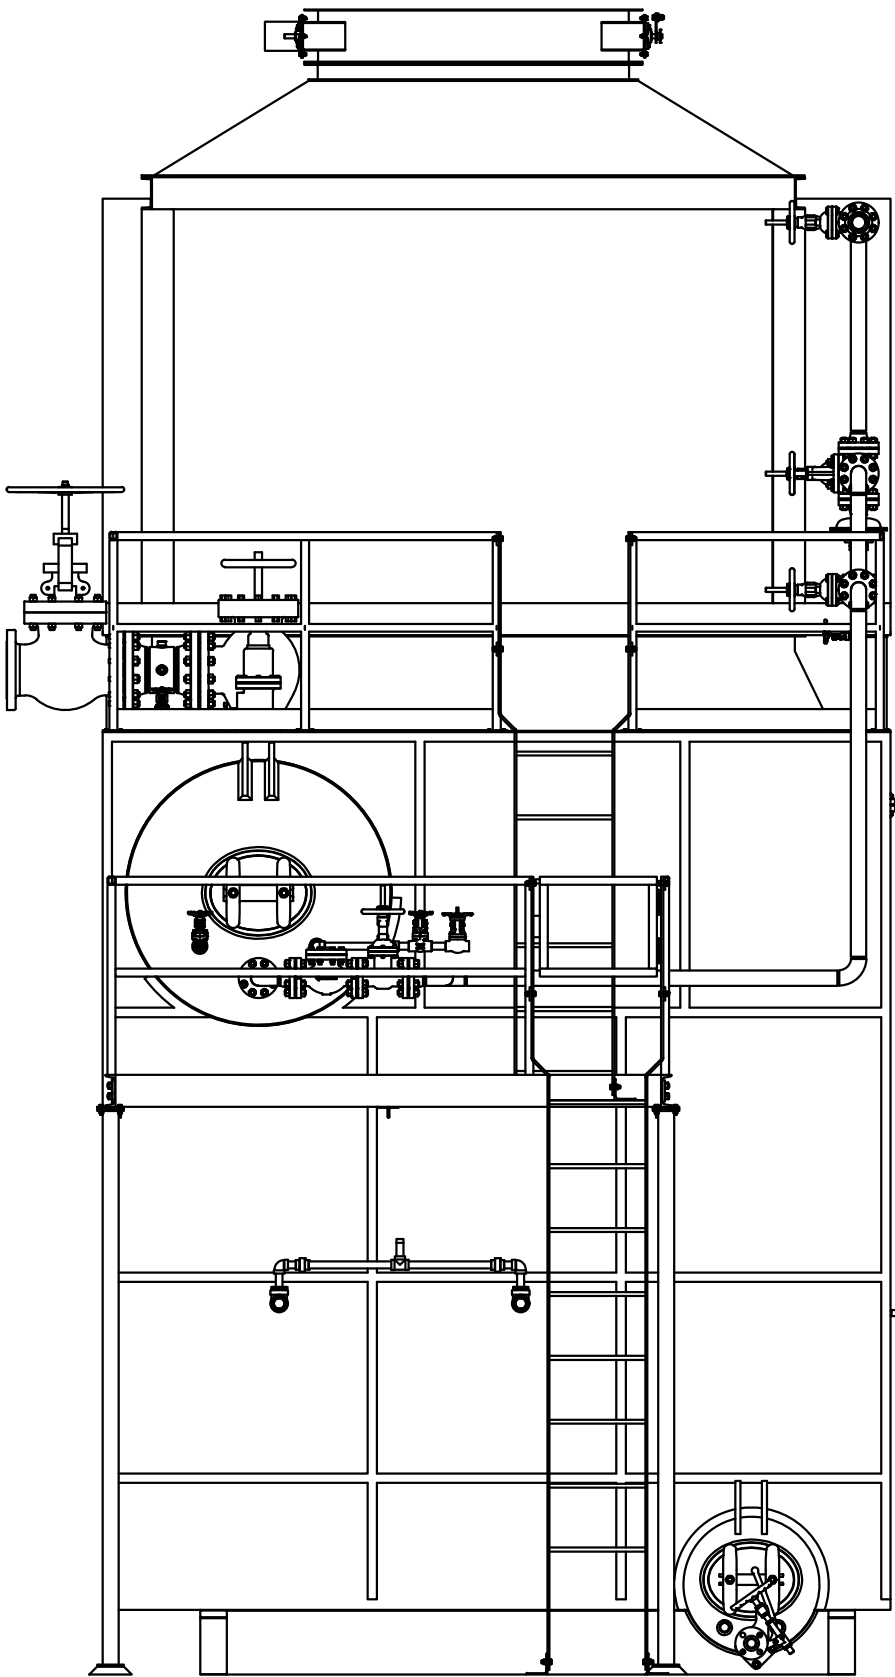

REAR ELEVATION

REV. #	REVISION DESCRIPTION	DATE	DRAWN	APPR.	P.M.

QC STAMP	PRODUCTION STAMP	ENGINEERING STAMP

NOTICE: THIS DRAWING AND ALL FEATURES SEPARATELY OR COLLECTIVELY DISCLOSED THEREBY OR EMBOSSED THEREIN ARE THE PROPERTY OF SUPERIOR BOILER, LLC. THE DRAWING SHALL NOT BE REPRODUCED OR COPIED, AND MUST BE RETURNED IMMEDIATELY UPON REQUEST. NO INFORMATION PROVIDED THEREIN SHALL BE COMMUNICATED, DISCLOSED, OR USED IN ANY MANNER, IN WHOLE OR IN PART EXCEPT AS AND TO EXTEND PREVIOUSLY EXPRESSLY AUTHORIZED IN WRITING BY THE COMPANY.

**SUPERIOR BOILER**  
PHONE: 1-804-226-8227  
FAX: 1-804-226-9321  
WWW.SUPERIORBOILER.COM

ALL DRAWING DIMENSIONS ARE ROUNDED TO 1/16" (0.0625") UNLESS OTHERWISE SPECIFIED.

REFERENCE STANDARD  
S.B. TOLERANCE  
DOCUMENT FOR  
ALLOWABLE SHOP  
CONSTRUCTION  
TOLERANCES

DRAWING NAME  
**GENERAL ARRANGEMENT**

CONTRACTOR	PROJECT

DRAWN BY MS	APPR. BY	PROJ. MGR.	MODEL NUMBER 100-DS-XXX	SCALE 3/8" = 1'	REV. # 0
DATE 08/19/2022	DATE	DATE	DRAWING NUMBER	SIZE D	